411 Restaurant & Tobacco Store Sam Patel

OWNER

Sam Patel Shyam Dutt Inc. 103 Brick Mill Road Maryville, TN 37801

Contact: Sam Patel
Phone: (856)-870-3735
Email: brickmillmkt@gmail.co

ARCHITECT

oysk³ Architects
1545 Western Avenue, Suite 100
Knoxville, TN 37921
Contact: Steve Young
Phone: (865) 523-8200
Email: office@oysk3architects.cor

CIVIL ENGINEER

Abbie Jones Consulting
Contact: Abbie Jones
Phone: (859)-559-3443
Email: abbie@abbie-jones.com

ELECTRICAL ENGINEER

Hampton Engineers, LLC
Contact: Harvey Hampton
Phone: (865)-360-3624
Email: email@server.com

MECHANICAL ENGINEER

Knauss Engineering and Design 703 Nance Ferry Rd. Blaine, TN 37721 Contact: Greg Knauss Phone: (865) 740-3361 Email: gknauss@comcast.net

STRUCTURAL ENGINEER

Smith Engineering Solutions
Contact: Ryan Smith
Phone: (865) 742-6738
Email: ryan@smithengineeringsolutions.com

CONTRACTOR

Company Name
Company Street Address
City, State, Zip code
Contact: Name
Phone: (###) ###-####
Email: email@server.com

5022 US HWY 411, Maryville, Tennessee, 37801



SHEET INDEX						
SHEET NUMBER	SHEET NAME	SHEET ISSUE DATE				
01 - GENERAL						
G000	PROJECT INFORMATION	6/23/2025				
04 - CIVIL						
C100	EXISTING CONDITIONS	6/18/2025				
C101	EXISTING-DEMO	6/18/2025				
C300	GRADING & DRAINAGE PLAN	6/18/2025				
C400	UTILITY PLAN	6/18/2025				
06 - ARCHITECTURAL						
A100	ARCHITECTURAL SITE PLAN	6/23/2025				
A101	LANDSCAPE PLAN	6/23/2025				
A102	MAIN FLOOR PLAN	6/23/2025				
A201	EXTERIOR ELEVATIONS	6/23/2025				
A202	EXTERIOR ELEVATIONS	6/23/2025				
07 - ELECTRICAL	,	·				
E-1	PHOTOMETRICS	6/19/2025				
E-2	PHOTOMETRICS	6/19/2025				

ABBREVIATIONS

HEATING, VENTILATION & AIR

CONDITIONING

AB	ANCHOR BOLT	INSUL	INSULATION
A/C	ANCHOR BOLT AIR CONDITIONING ACOUSTICAL CEILING TILE	INT	
ACT	ACOLISTICAL CEILING THE	JST	JOIST
ACE	ADOVE EINIGHED EI OOD		
ALLINA	ABOVE FINISHED FLOOR ALUMINUM	NAN	MANUFACTURER MAXIMUM
ALUM	ANCHOR	MAX	MATCHANICAL
		MECH	
	AUTHORITY HAVING JURISTICTION	MIN	MINIMUM
	BOARD	MO	MASONRY OPENING
BM	BEAM	MRGB	
C TO C	CENTER TO CENTER CARPET CONSTRUCTION JOINT CONCRETE MASONRY UNIT	MTL	METAL
CPT	CARPET	OC	ON CENTER
CJ	CONSTRUCTION JOINT	PBO	PROVIDED BY OWNER
CMU	CONCRETE MASONRY UNIT	PL	PLATE
COL	COLUMN	PRF-FI	NG PRE-ENGINEERED
CONC	COLUMN CONCRETE		PLASTIC LAMINATE
CONST	R CONSTRUCTION		D PLYWOOD
CONT	CONTINUOUS		PULL STATION
CONTE	CONTINUOUS R CONTRACTOR	DT	PRESSURE TREATED OR PAINT
	CERAMIC TILE		
		רוט	
DEI	DETAIL DRINKING FOUNTAIN	PVC	POLYVINYL CHLORIDE PIPE RESILIENT
DF	DRINKING FOUNTAIN	RESIL	RESILIENT
	DOWN SPOUT	REI	RETAINING
DWG EA	DRAWING	SHT	SHEET STEEL
EL	ELEVATION	TEMP	TEMPERATURE
EPS	EXPANDED POLYSTYRENE	T&G	TONGUE AND GROOVE
EQUIP	EQUIPMENT	TOC	TOP OF CONCRETE
EWH	EXPANDED POLYSTYRENE EQUIPMENT ELECTRIC WATER HEATER EXPANSON OR EXPOSED	TOF	TONGUE AND GROOVE TOP OF CONCRETE TOP OF FOOTING
EXP	EXPANSON OR EXPOSED	TOS	TOP OF STEEL
FYT	EYTERIOR	TOW	TOP OF WALL
EXIST	EXISTING	TPH	TOP OF STEEL TOP OF WALL TOILET PAPER HOLDER
FF.	FINISHED FLOOR/FINISH FACE	TYP	TYPICAL
FF	FIRE EXTINGUISHER	VCT	VINYL COMPOSITE TILE FLOORING
FEC	FIRE EXTINGUISHER CABINET	VB	VINYL BASE
FG	FIBERGLASS	W/	WITH
FHC	FIDE LIGOE CADINET	WC	WATER CLOSET
FLASH	FIRE HOSE CABINET		
FLASH	FLASHING	WD	WOOD
	FIBER-REINFORCED PLASTIC	XPS	WOOD
GA GB	GAUGE	32°4'8"	
		Ø	DIAMETER
GYP BE		@	AT
	HARDWOOD	&	AND
HT	HIGH OR HEIGHT		

GENERAL NOTES

G1 SCOPE OF WORK: SINGLE STORY 5,000SF NEW BUILDING WITH TWO TENANT SPACES. BUILDING IS WOOD FRAME ON CONCRETE SLAB. THE FIRST TENANT SPACE IS A 3,500SF RESTAURANT, AND THE SECOND TENANT SPACE IS A TOBACCO SHOP WITH A DRIVE THROUGH.

G2 ALL WORK SHALL BE PERFORMED IN ACCORDANCE WITH ALL LOCAL CODES, ORDINANCES, AMENDMENTS, & COVENANTS:

BLOUNT COUNTY
BLOUNT COUNTY ZONING ORDINANCE
2018 INTERNATIONAL BUILDING CODE
2018 INTERNATIONAL ENERGY CONSERVATION CODE
2018 INTERNATIONAL MECHANICAL CODE
2018 INTERNATIONAL PLUMBING CODE
2017 NATIONAL ELECTRIC CODE
2018 INTERNATIONAL FUEL GAS CODE
2018 INTERNATIONAL FIRE CODE
2018 NFPA 101 LIFE SAFETY CODE
2010 ADA STANDARDS FOR ACCESSIBLE DESIGN


G3 READ (OR CALCULATE) DIMENSIONS FROM PUBLISHED PRINTS OF CONSTRUCTION DRAWINGS; DO NOT "SCALE" FROM DRAWINGS, IN EITHER THEIR PUBLISHED OR ELECTRONIC FORMS.

G4 CONTRACTOR SHALL VERIFY EXISTING CONDITIONS & DIMENSIONS BEFORE BEGINNING CONSTRUCTION; ANY DISCREPANCIES MUST BE REPORTED TO 0YSK3 ARCHITECTS FOR JUSTIFICATION AND/OR CORRECTION; CONTRACTOR ASSUMES RESPONSIBILITY FOR CONDITIONS THAT ARE NOT REPORTED.

 $\underline{G5}$ CONTRACTOR SHALL FIELD-VERIFY COMPATIBILITY OF THE BUILDING WITH ALL SITE CONDITIONS; I.E., GRADES, ELEVATIONS, UTILITY LOCATIONS & INVERTS, OTHER EXISTING CONDITIONS, ETC.

G6 ALL FOOTINGS MUST REST ON UNDISTURBED OR SUITABLE, COMPACTED SUBSOIL.

<u>G7</u> MANUFACTURED TRUSSES, BEAMS, & OTHER ENGINEERED BUILDING SYSTEMS MUST BE DESIGNED BY THE MANUFACTURER'S ENGINEER, WHO SHALL BE REGISTERED IN THE STATE OF TENNESSEE; STAMPED, APPROVED SHOP DRAWINGS SHALL BE ON-SITE BEFORE ERECTION BEGINS.

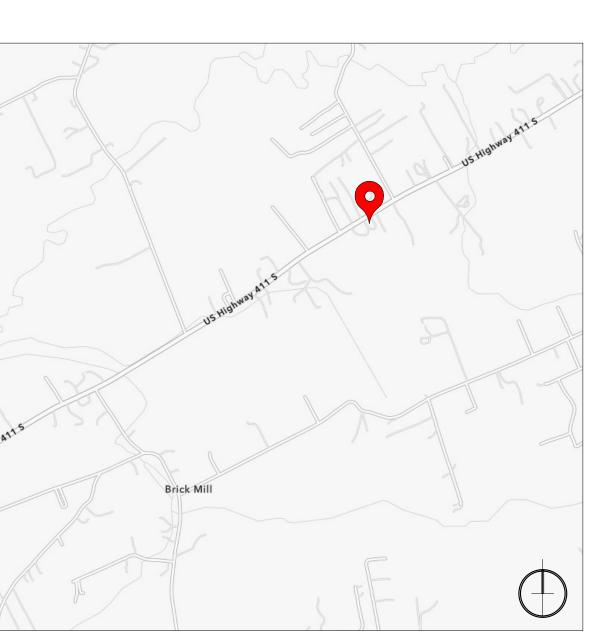

1 VICINITY MAP

PERIMINARY

ACHIECTS

ACHIECTS

ACHIECTS

ACHIECTS

BEST 82300

Office@oysk3architects.com

1 Restaurant & Tobacco Store m Patel

ISSUE DATE ISSUED FOR:

6/23/2025 Zoning Review

NAM BA


NAM B


DRAWN BY: KG


PROJECT INFORMATION


G000


PROJECT: 25091
© COPYRIGHT 2025

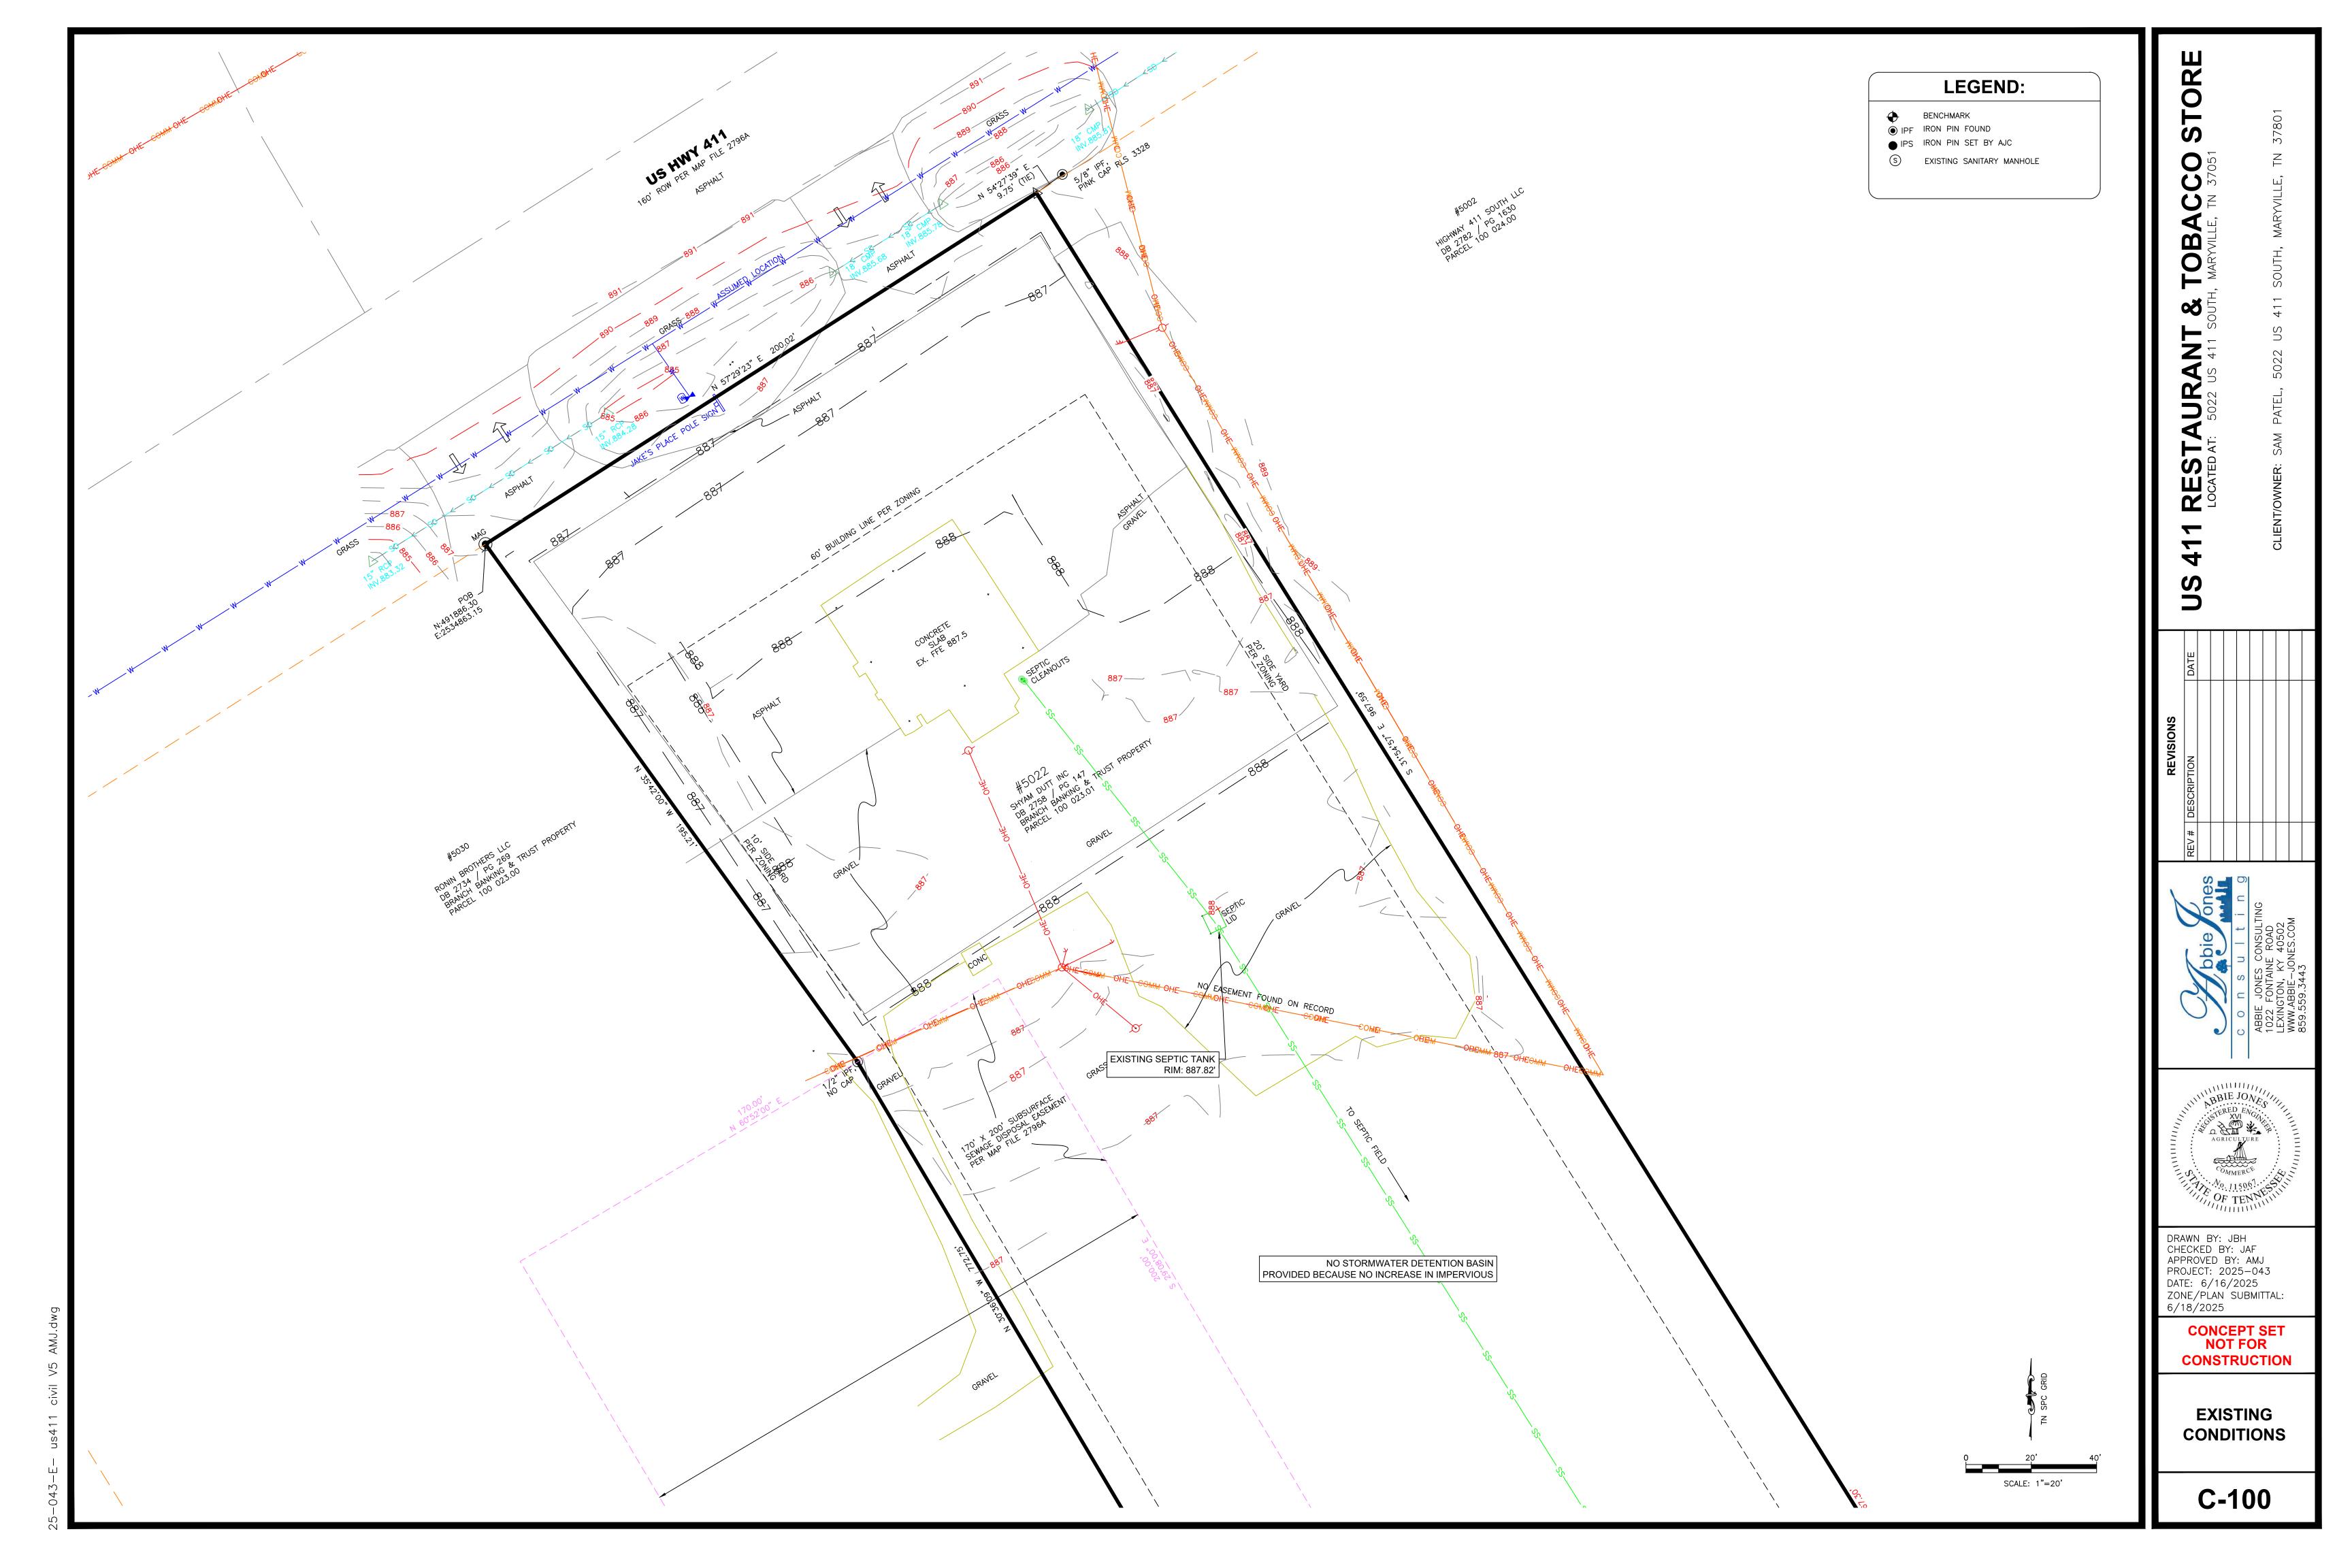

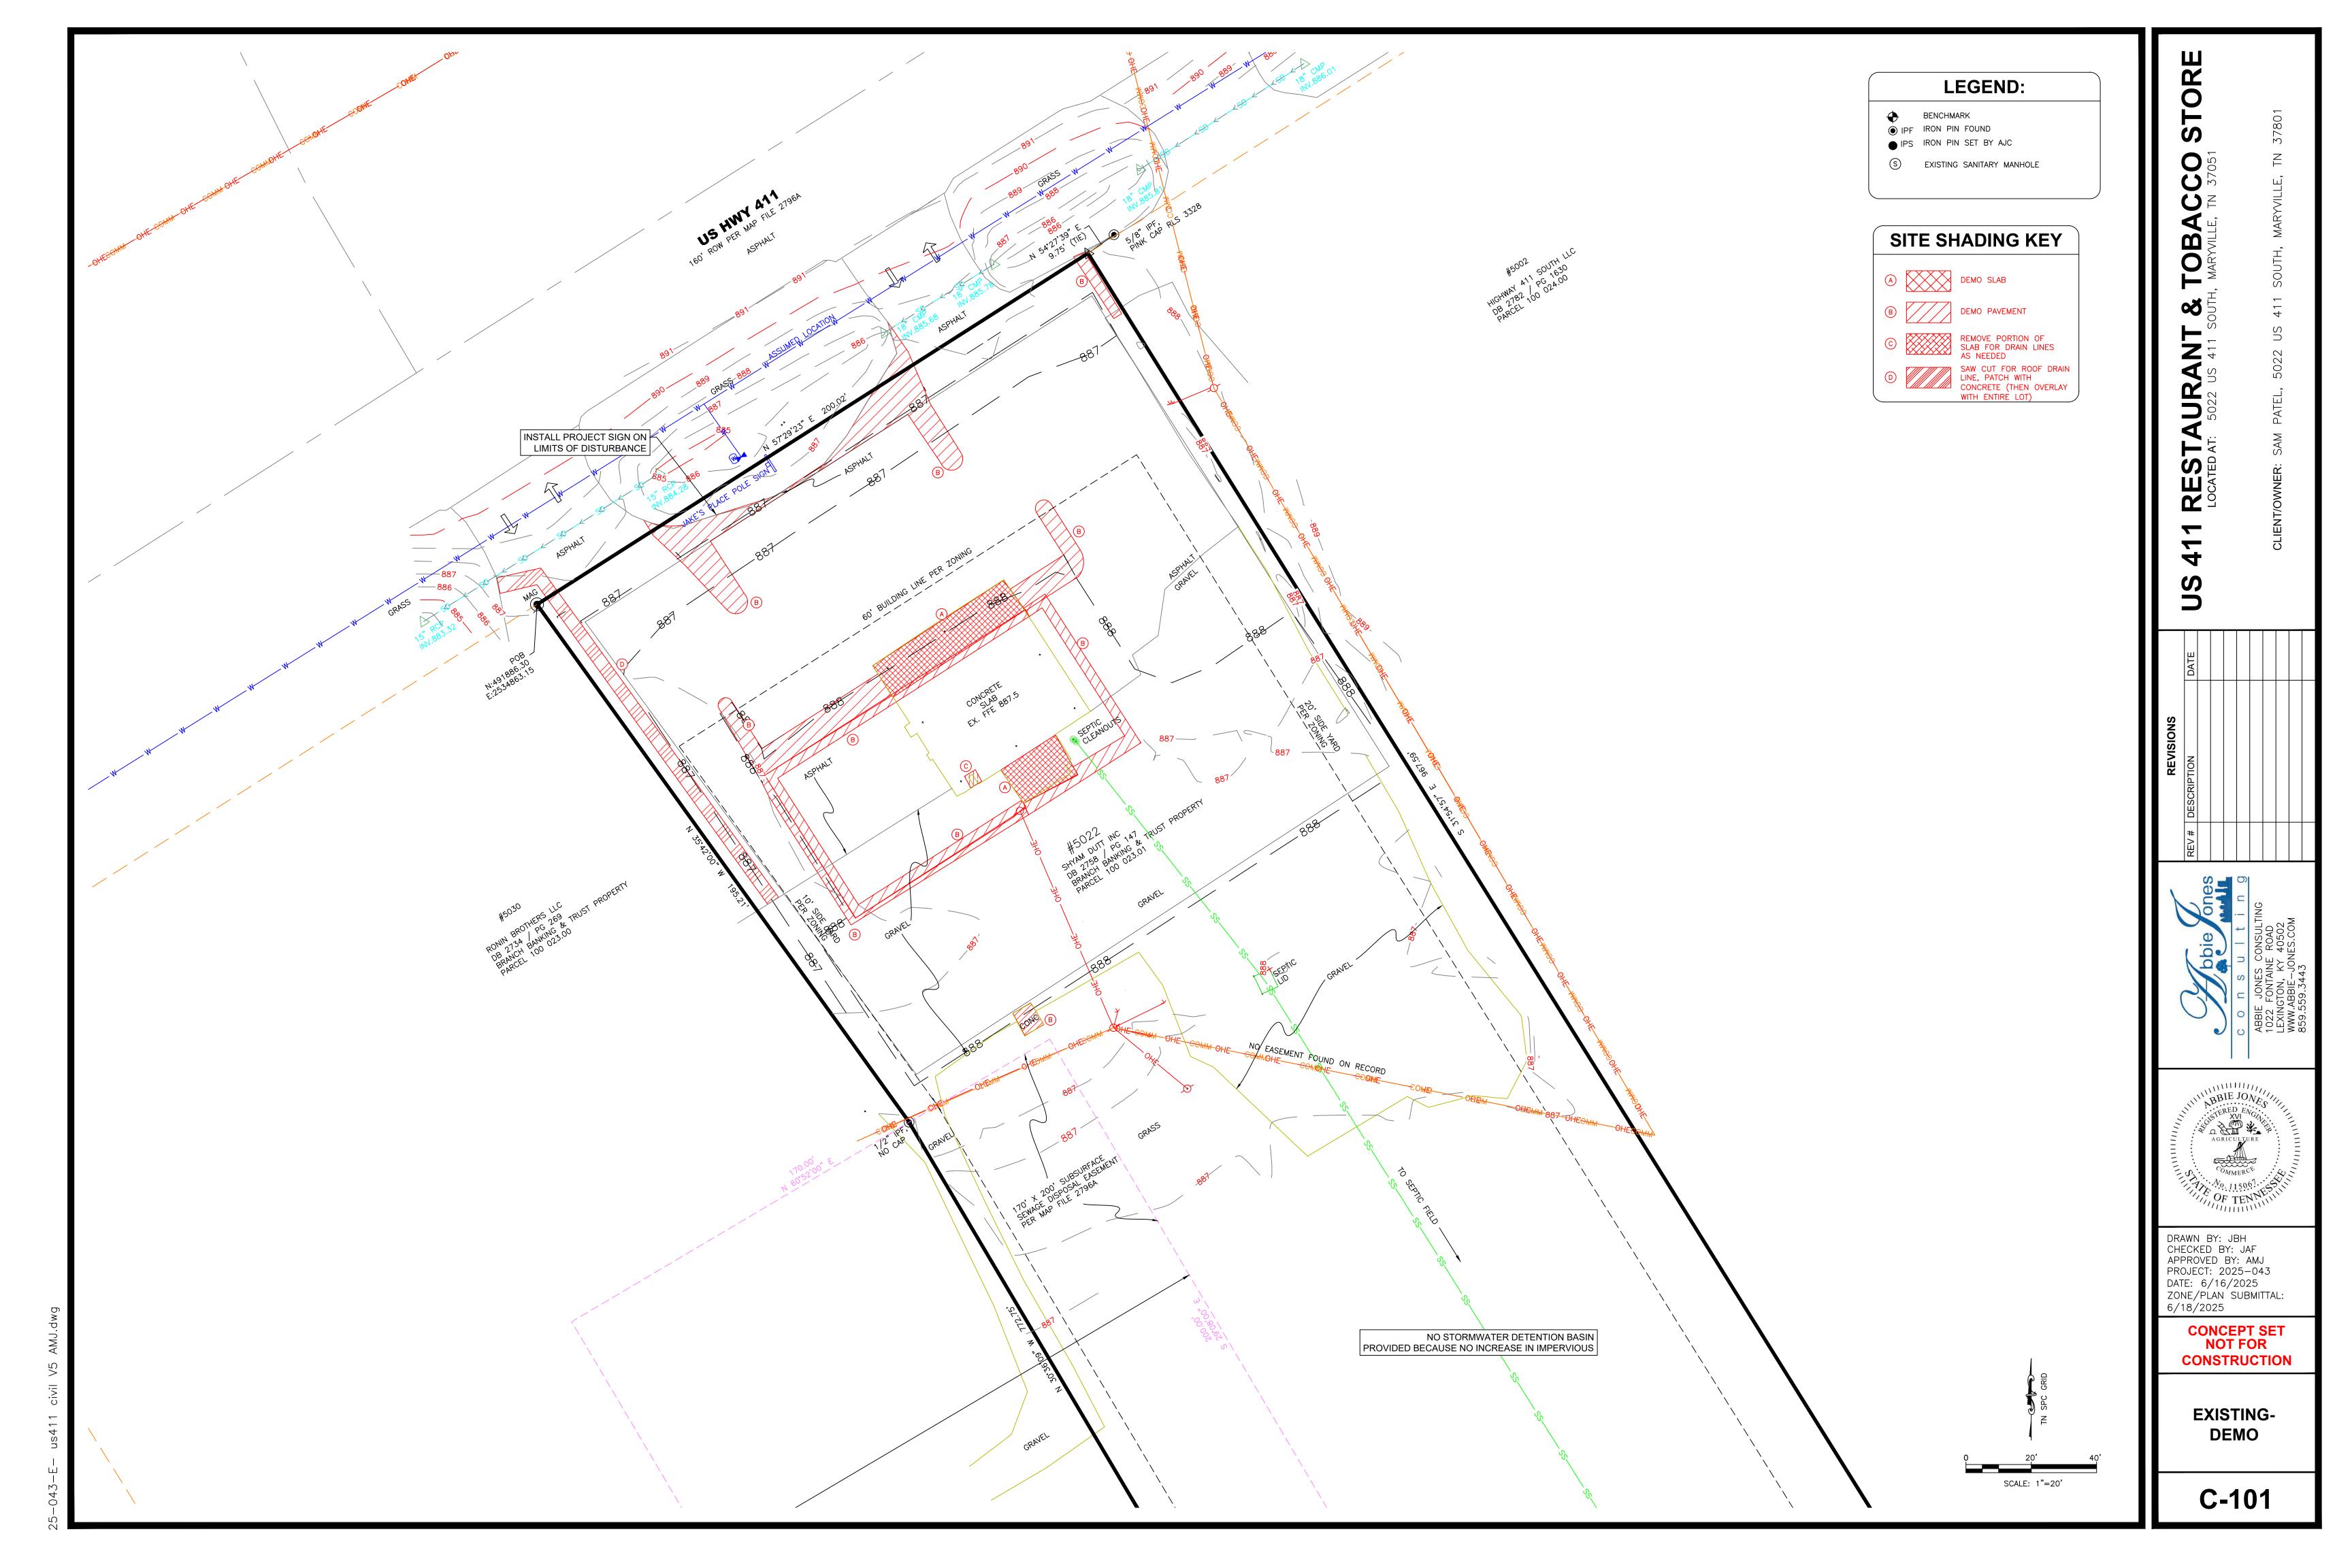

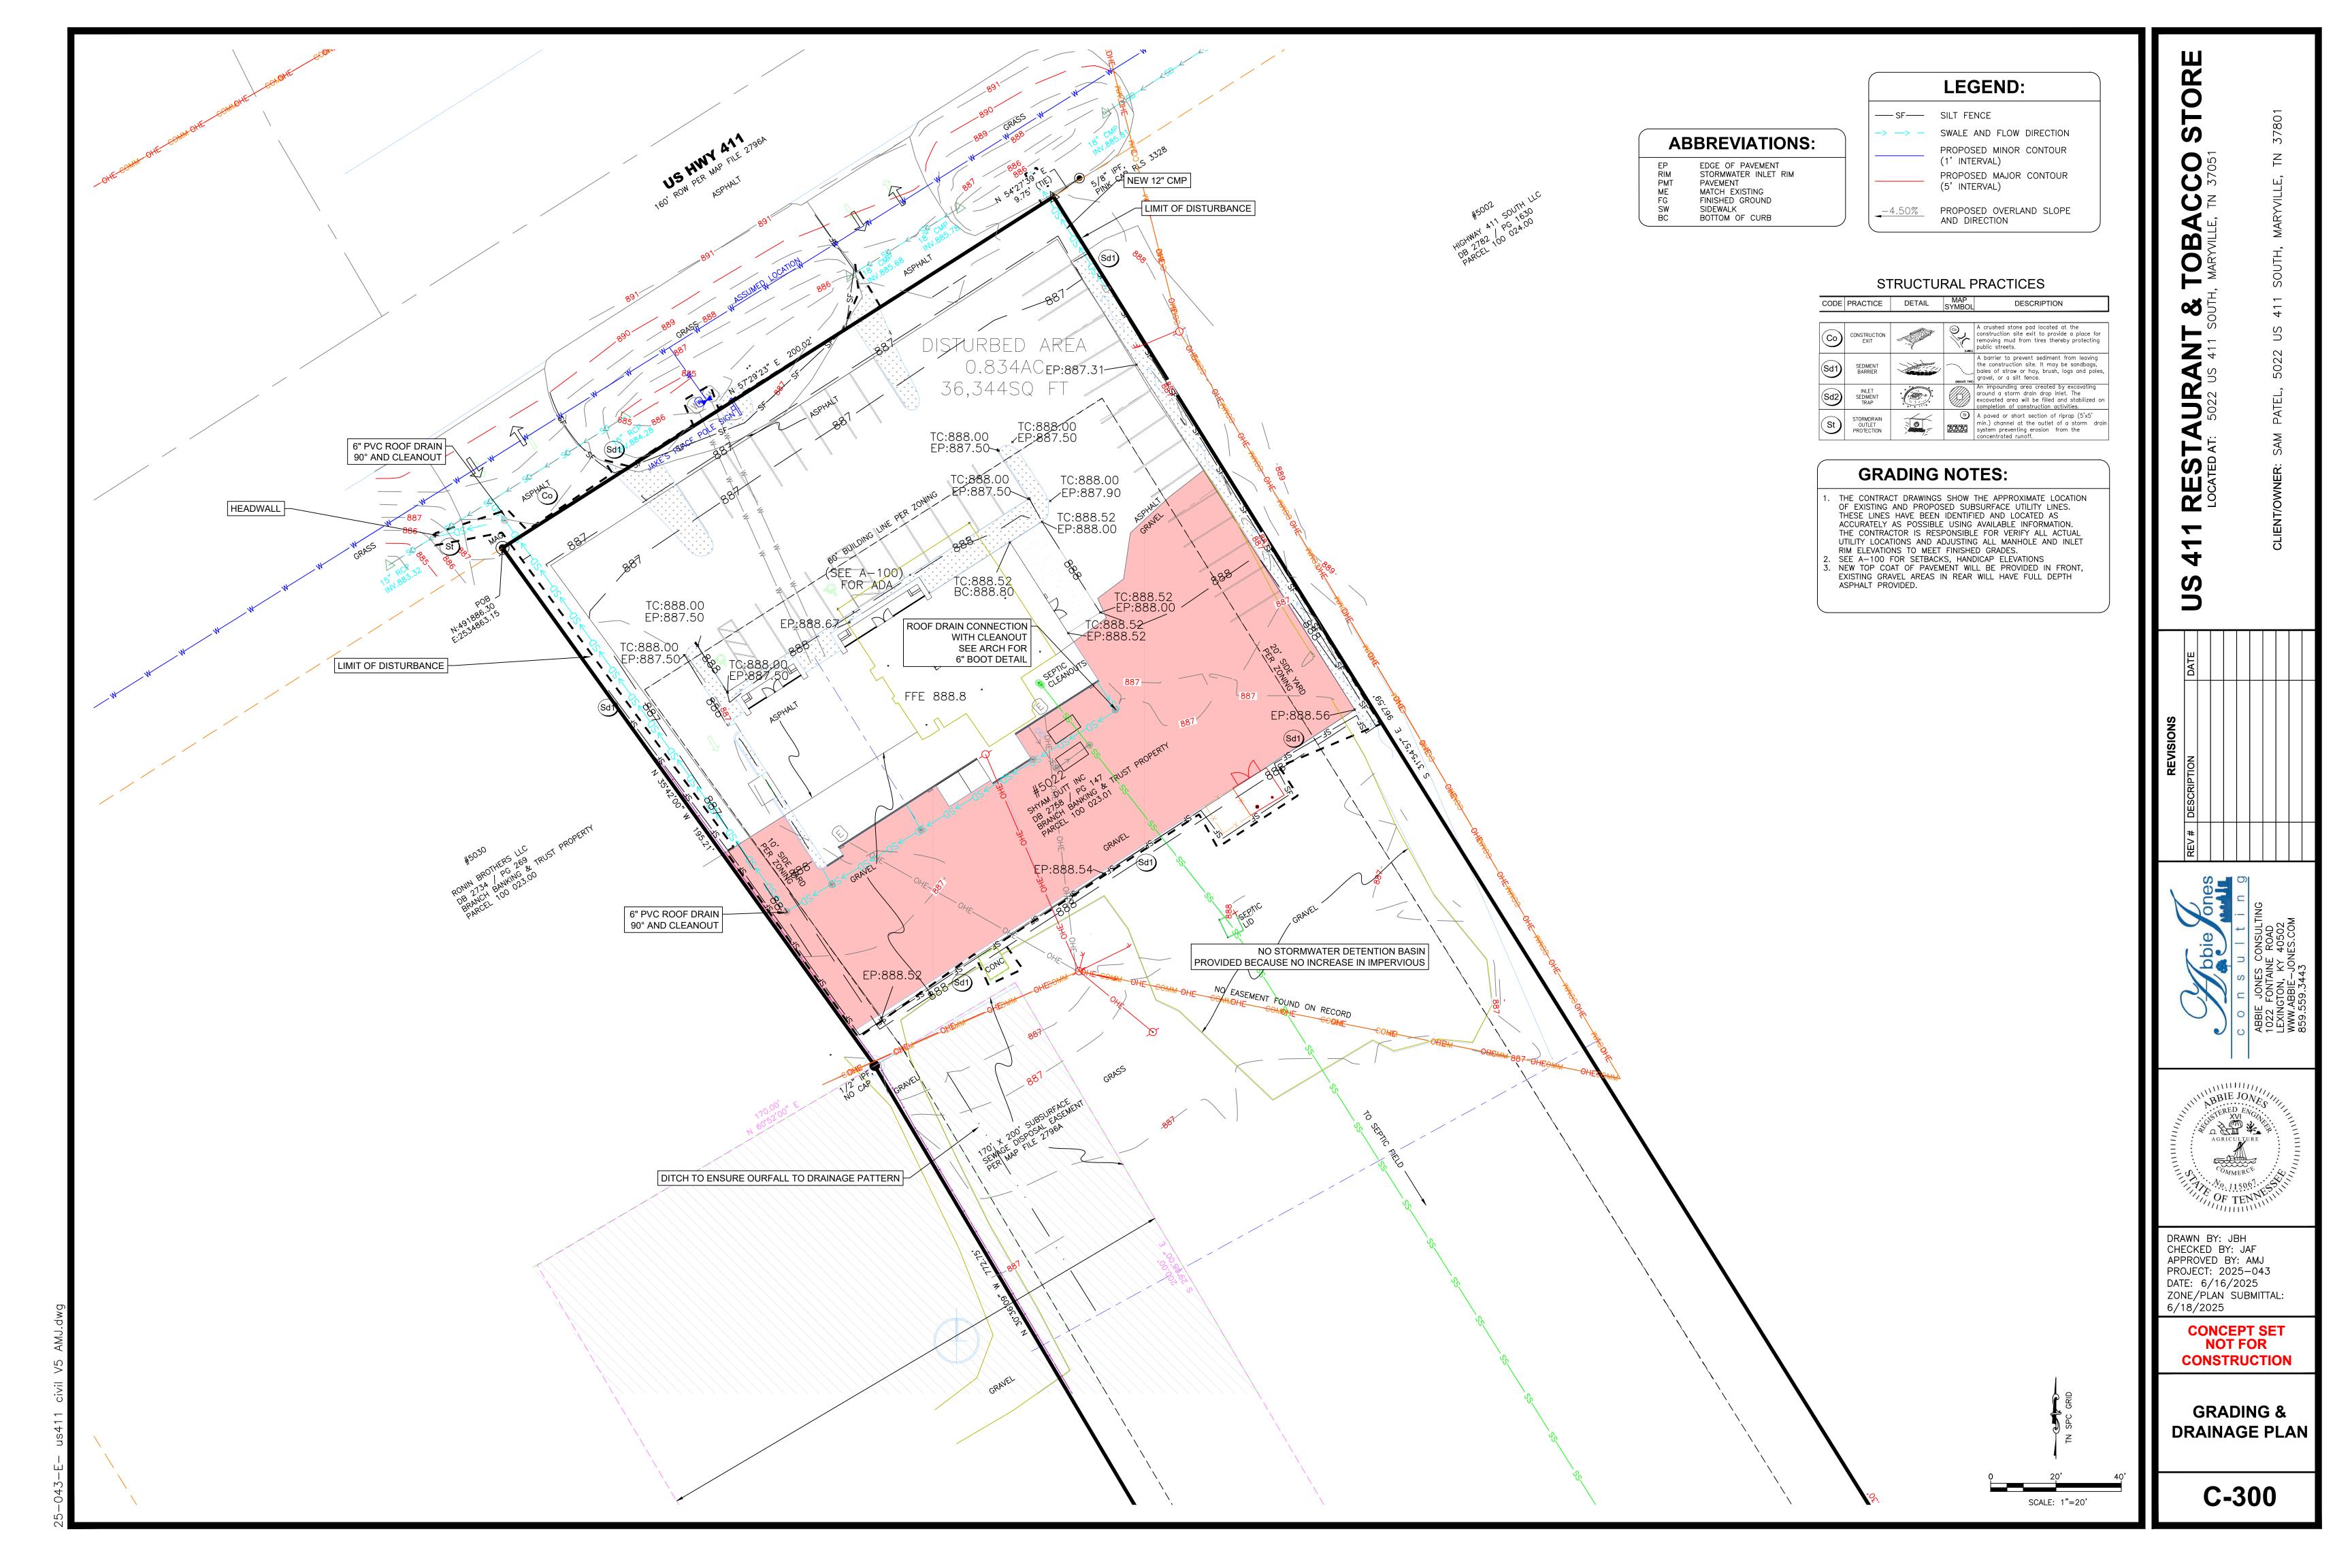

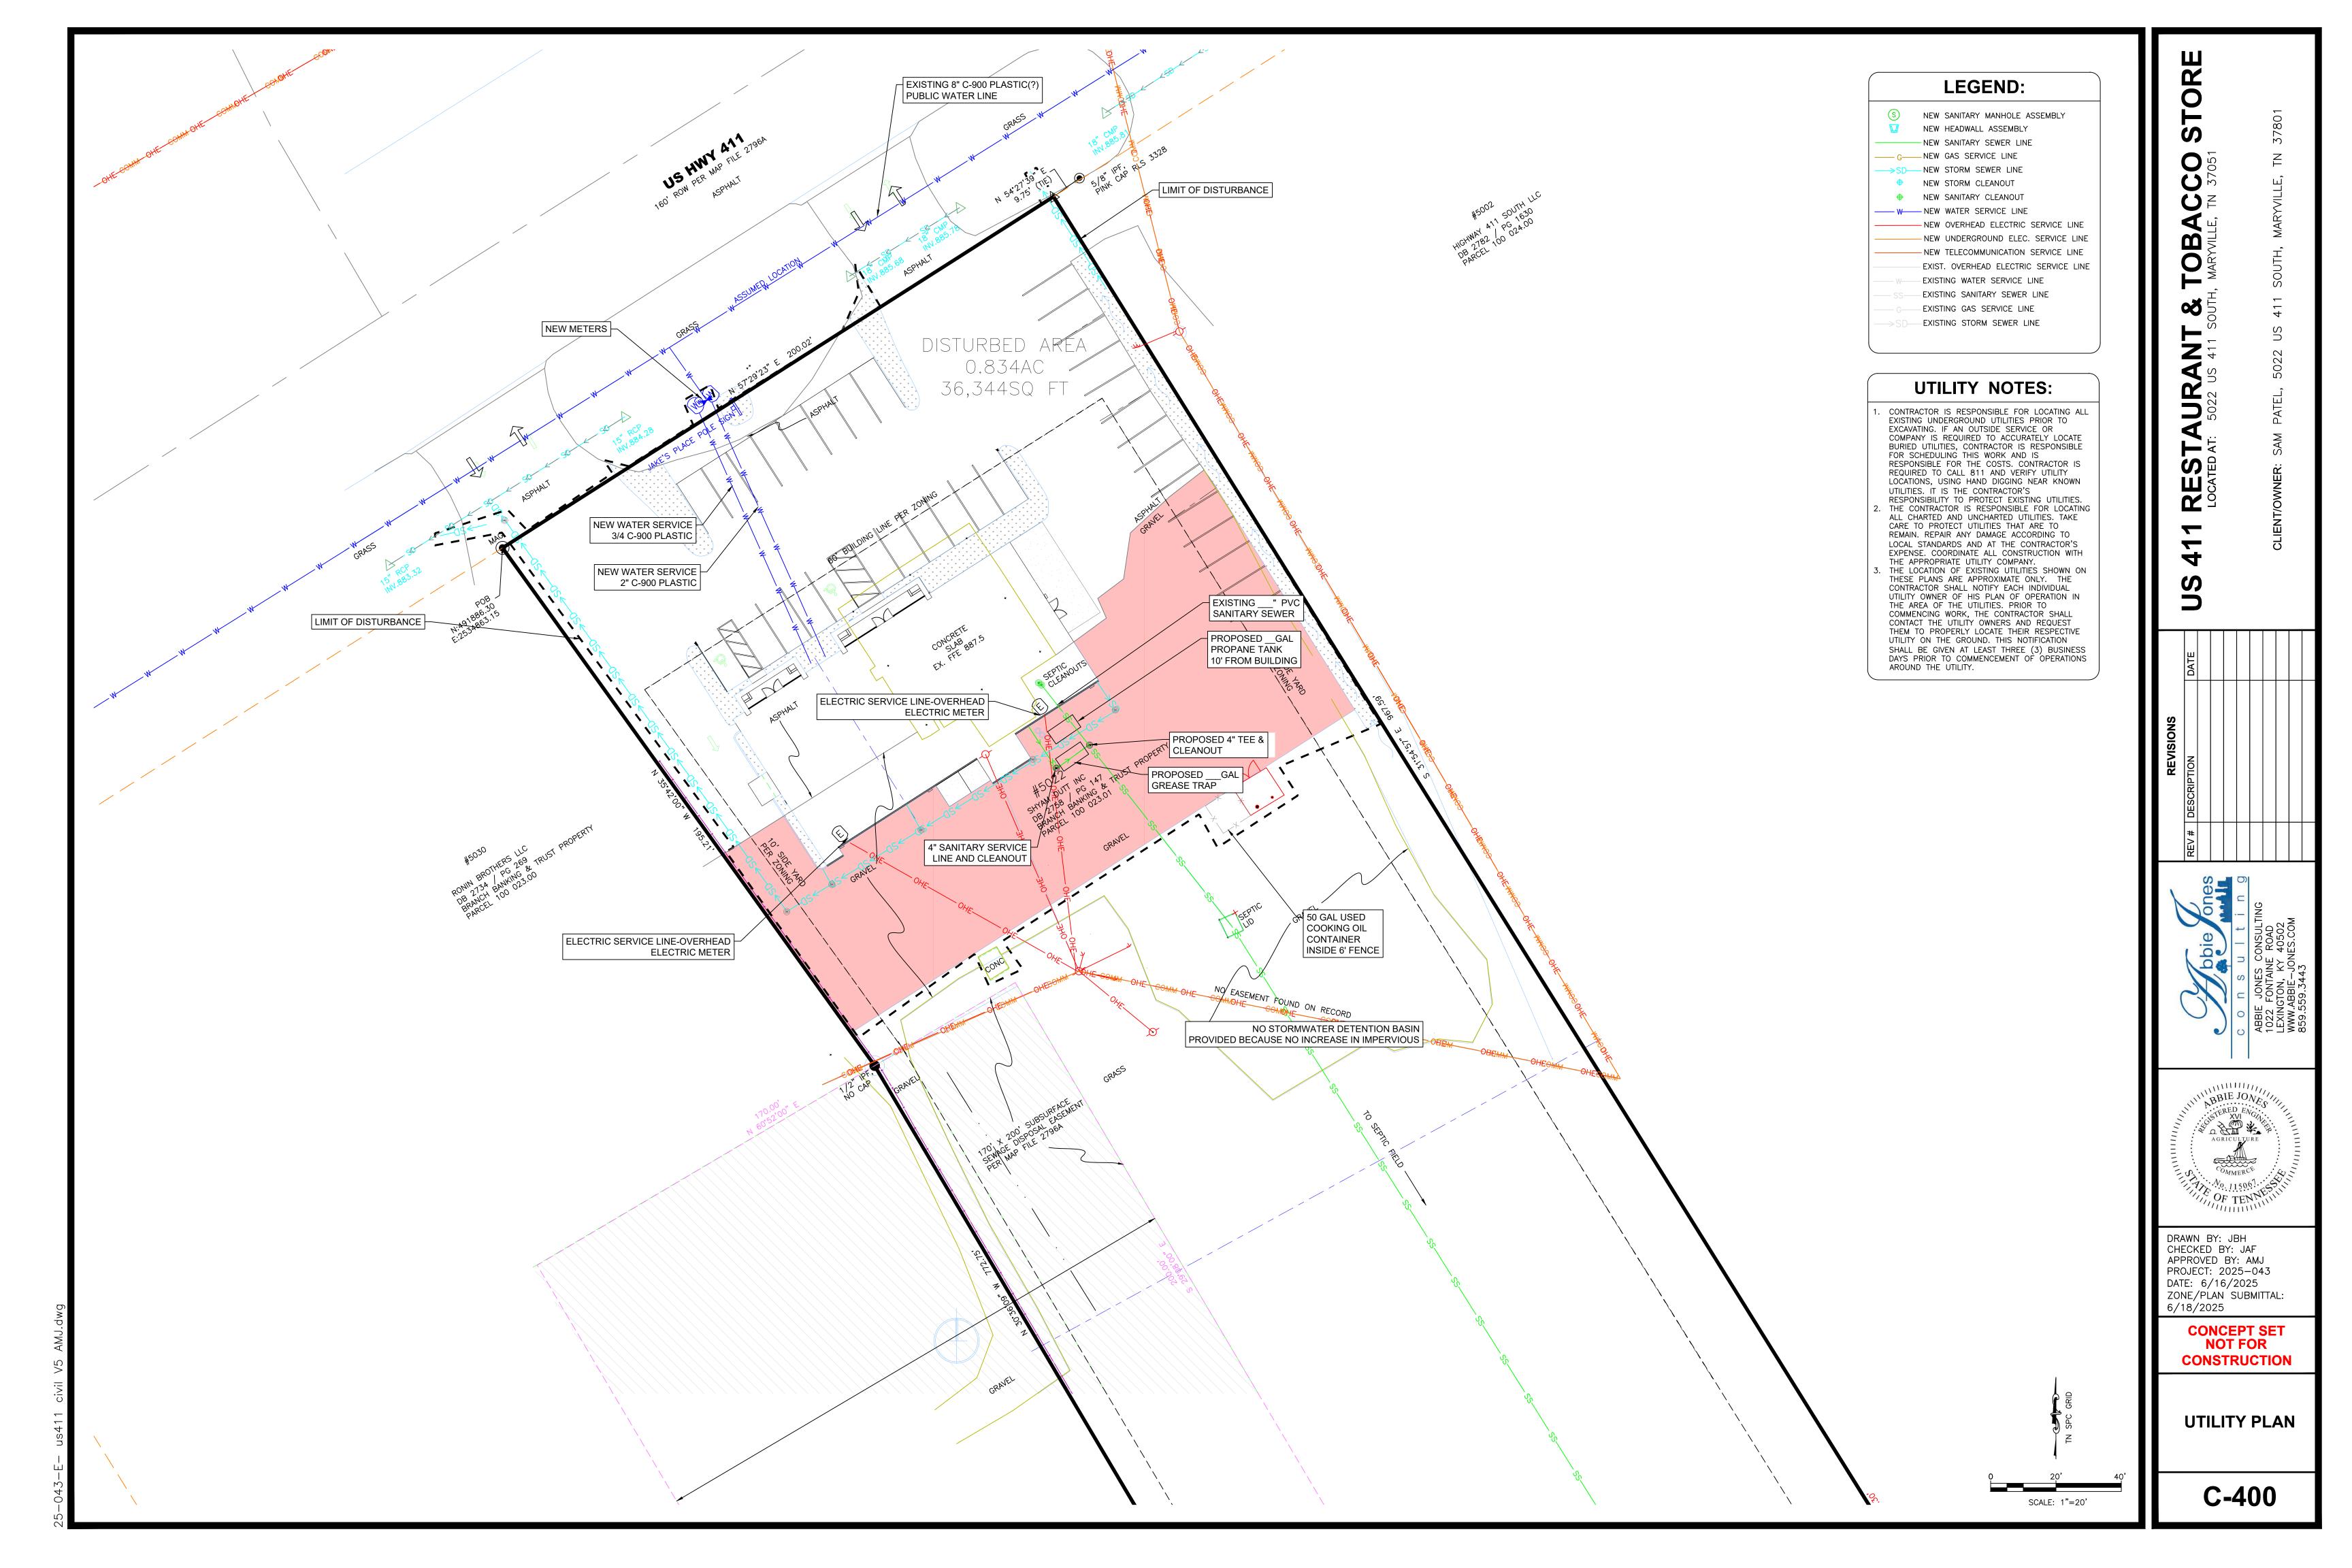

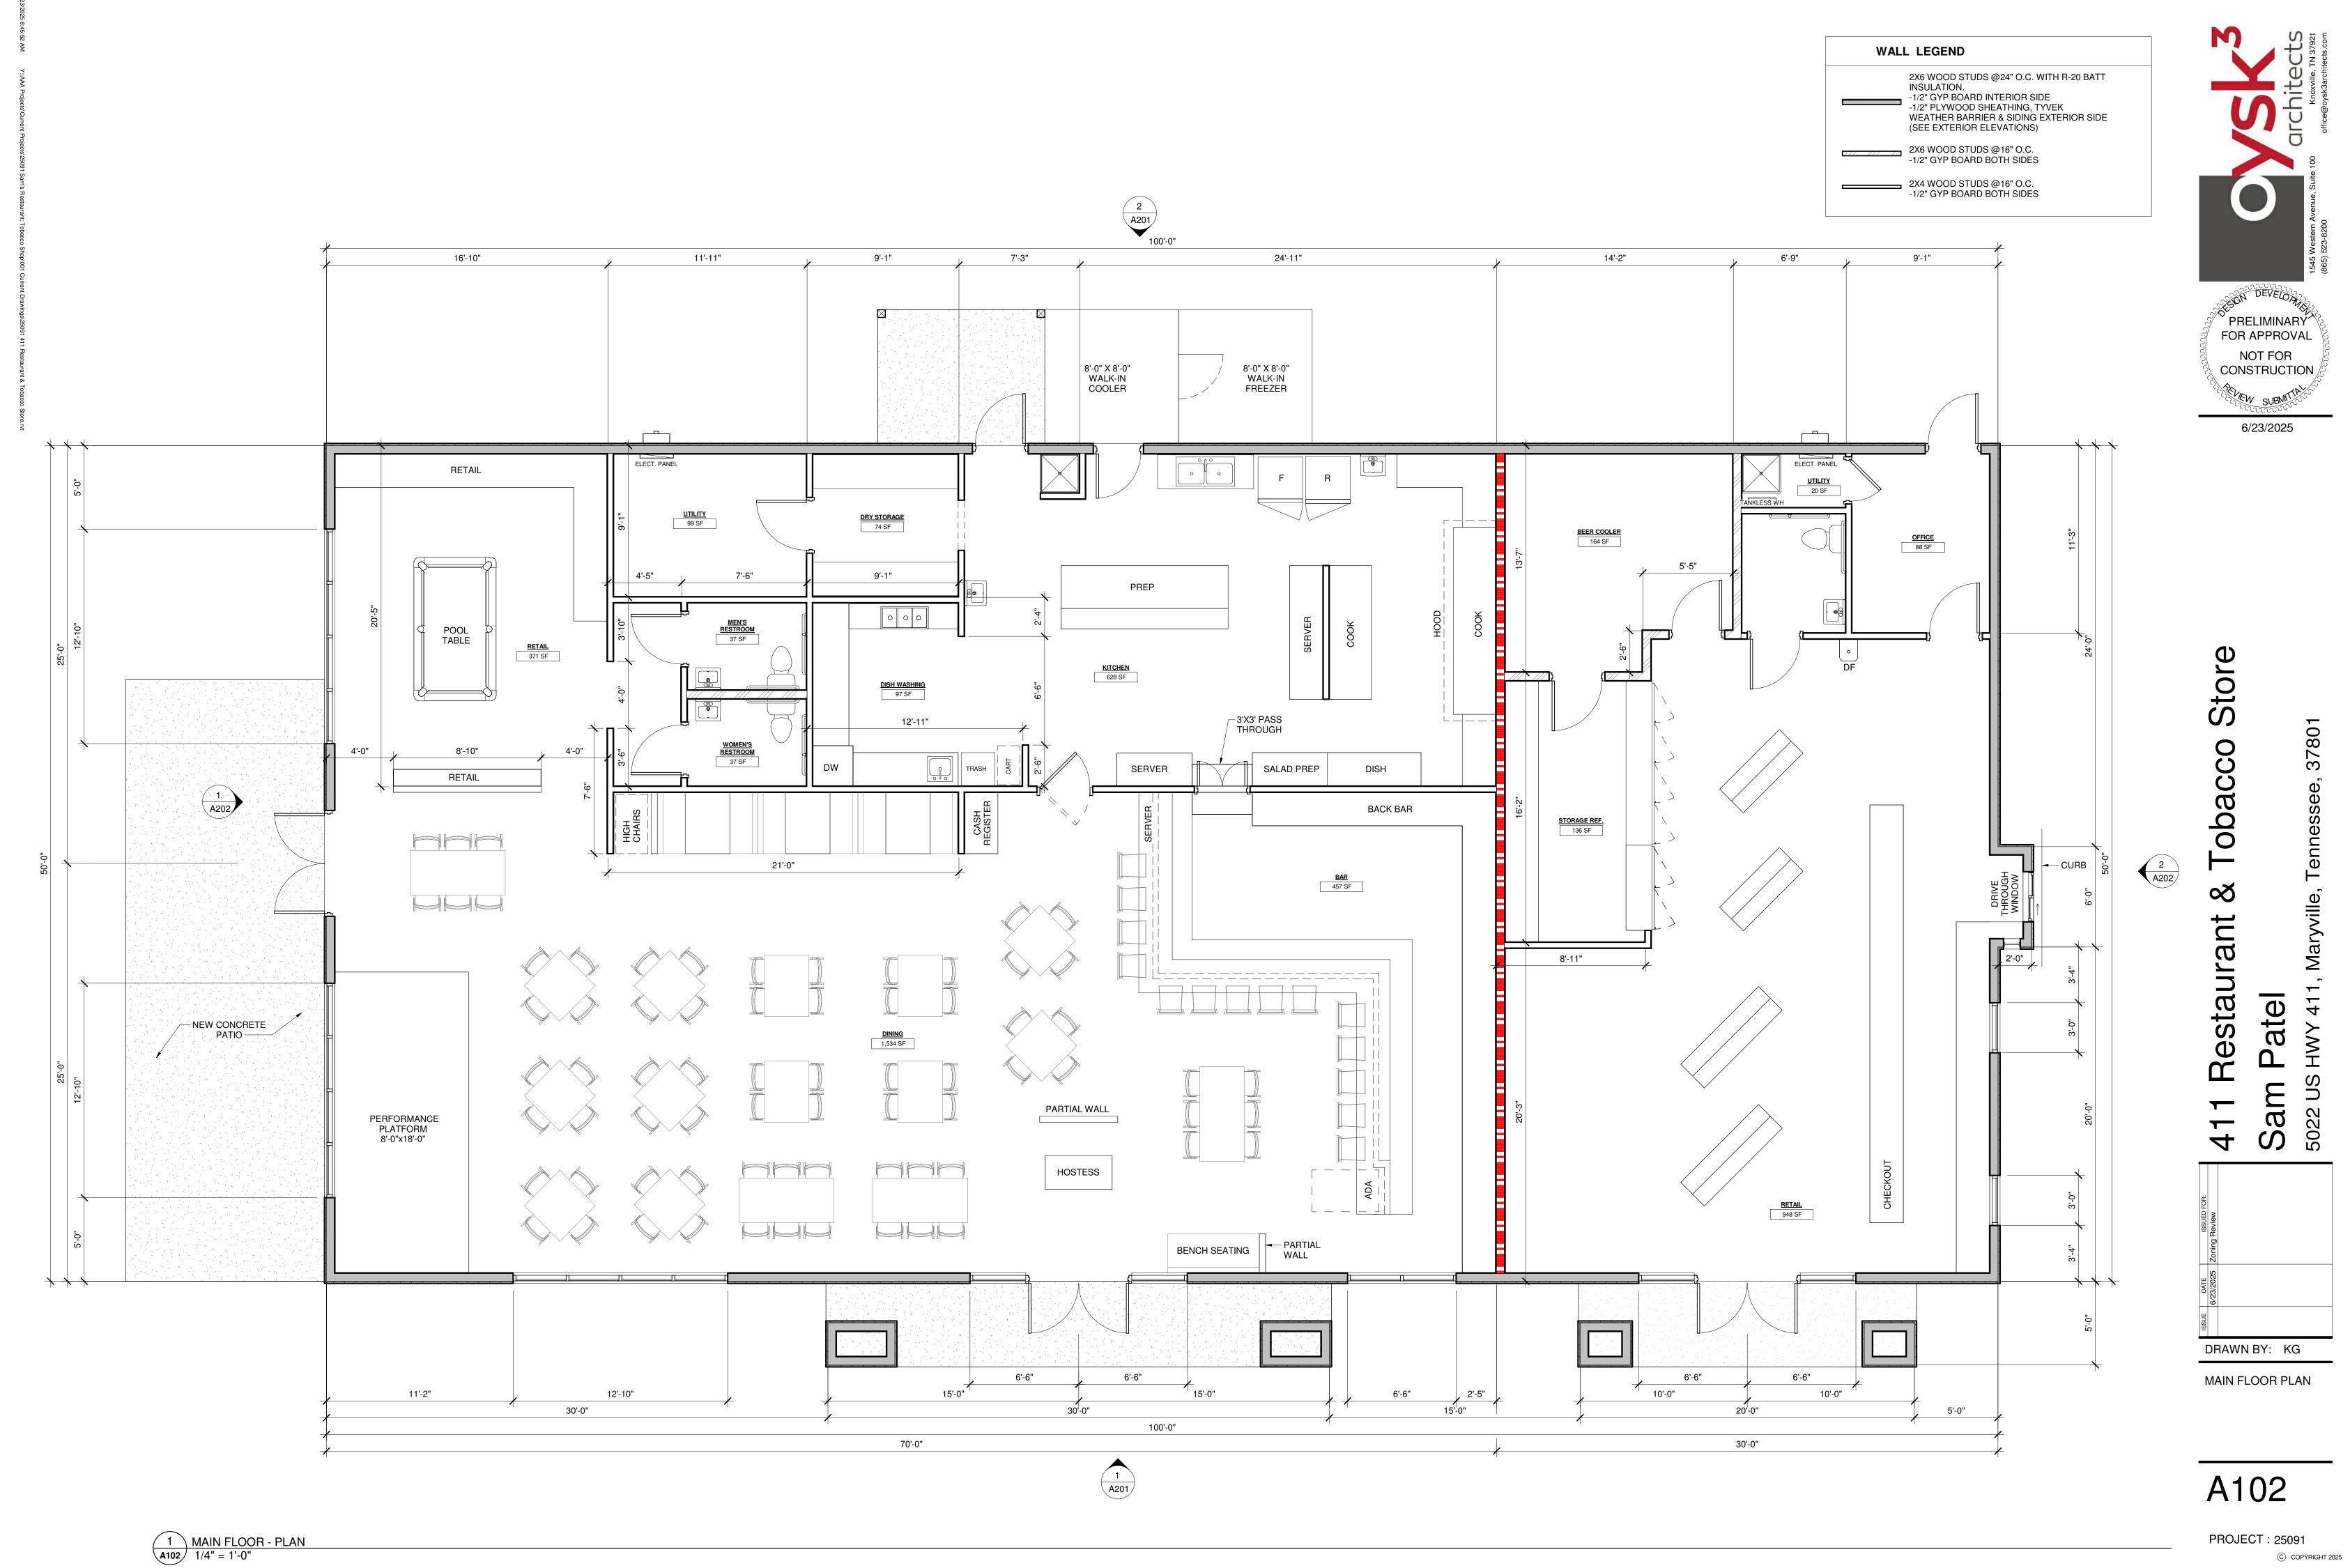

PROJECT: 25091

2

1 FRONT ELEVATION A201 1/4" = 1'-0"

DEVELON ΥPRELIMINARÝ FOR APPROVAL CONSTRUCTION /

ELEVATION KEYNOTES


STEEL C-CHANNEL


A201

MAIN LEVEL
0"

PROJECT: 25091 © COPYRIGHT 2025 1 (A)— **C** MAIN LEVEL 2

2 RIGHT ELEVATION A202 1/4" = 1'-0"

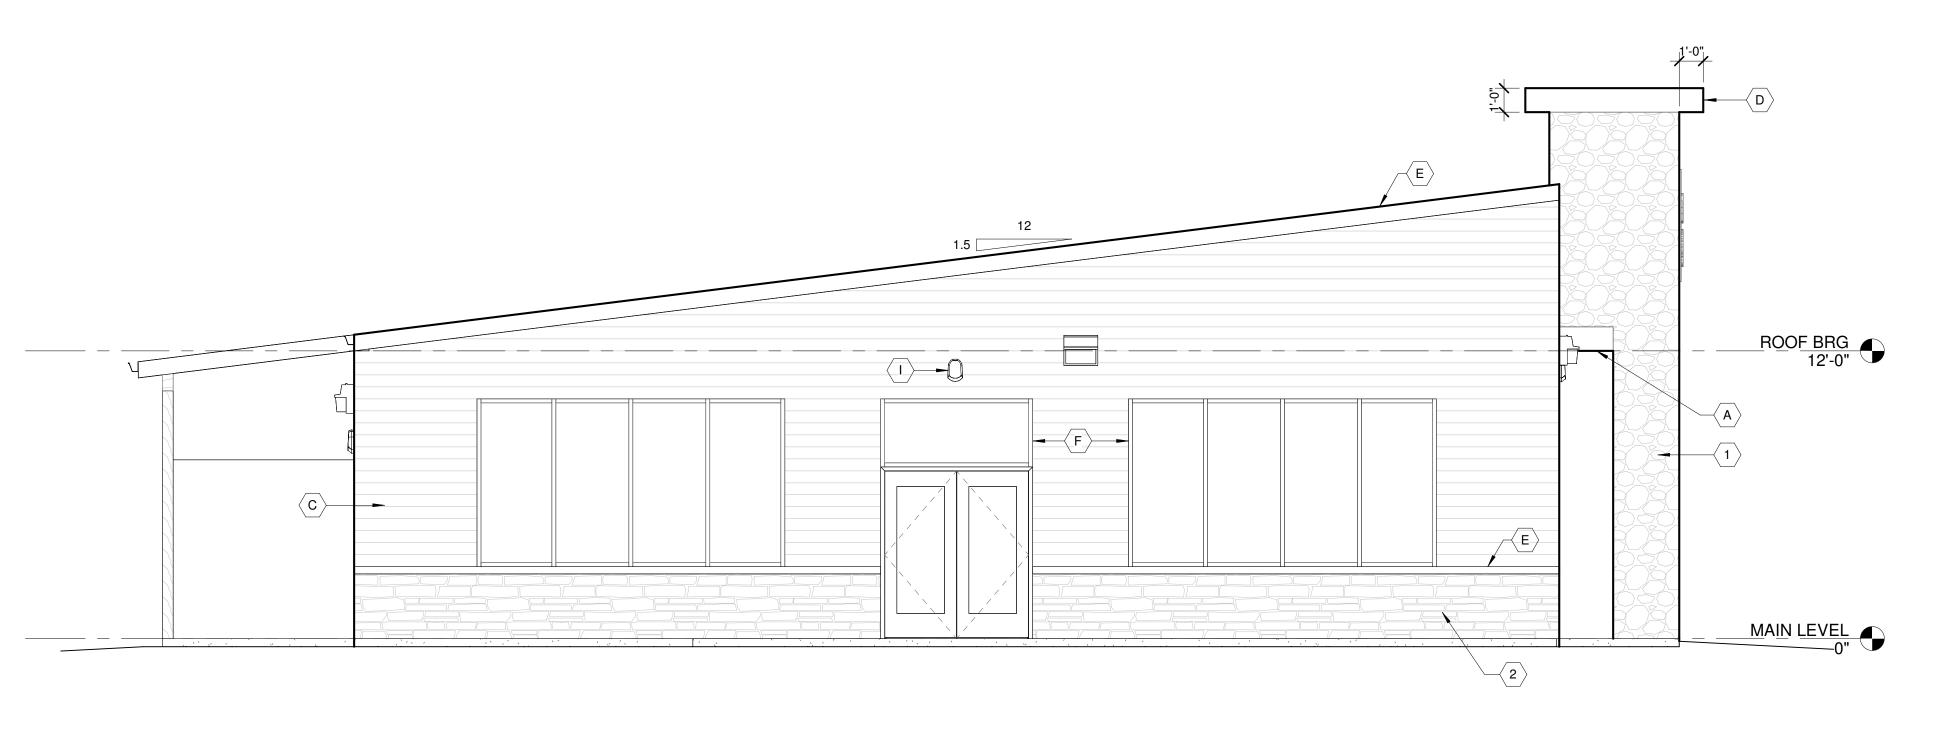

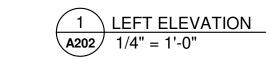

Tobacco Restaurant &

DEVELOADE DEVELOADE

ັ PRELIMINARY໌′[∕] FOR APPROVAL

NOT FOR CONSTRUCTION /

6/23/2025

Sam Pale. 5022 US HWY 411, N

DRAWN BY: KG

EXTERIOR ELEVATIONS

A202

PROJECT: 25091

PARKING

(PROVIDE WHERE APPLICABLE)

PARKING SIGN;

WHEELCHAIR SYMBOL;

R7-8D PENALTY SIGN

NCHC CODE. WHITE BACKGROUND WITH GREEN LEGEND

PAINT SHERWIN & WILLIAMS BLACK SEA

- 2" x 2" x .188 GA. STEEL TUBE;

LOCATE +3'-0" FROM CURB

– PAVEMENT OR EARTH

SW2112- DRIVEN INTO GROUND;

HANDICAP PARKING SIGN SHALL

LOCAL CODES & REGULATIONS

CONFORM W/ CURRENT STATE &

BOLTS, NUTS, & WASHERS;

1'-0"x1'-6"x.08 GA. ALUMINUM R7-8A ACCESSIBLE

SIGN TO READ "RESERVED PARKING", WITH

R7-8 SIGN TO BE USED

DESIGNATES (2) ADJACENT

VAN

RESERVED

PARKING

G

MAXIMUM PENALTY \$200

2 ACCESSIBLE PARKING SIGN DETAIL A100 3/4" = 1'-0"

WHEN ONE SIGN

SPACES


DEVELOADOR ´ PRELIMINARÝ´ FOR APPROVAL NOT FOR CONSTRUCTION /

DRAWN BY: KG

ARCHITECTURAL SITE PLAN

A100

PROJECT: 25091

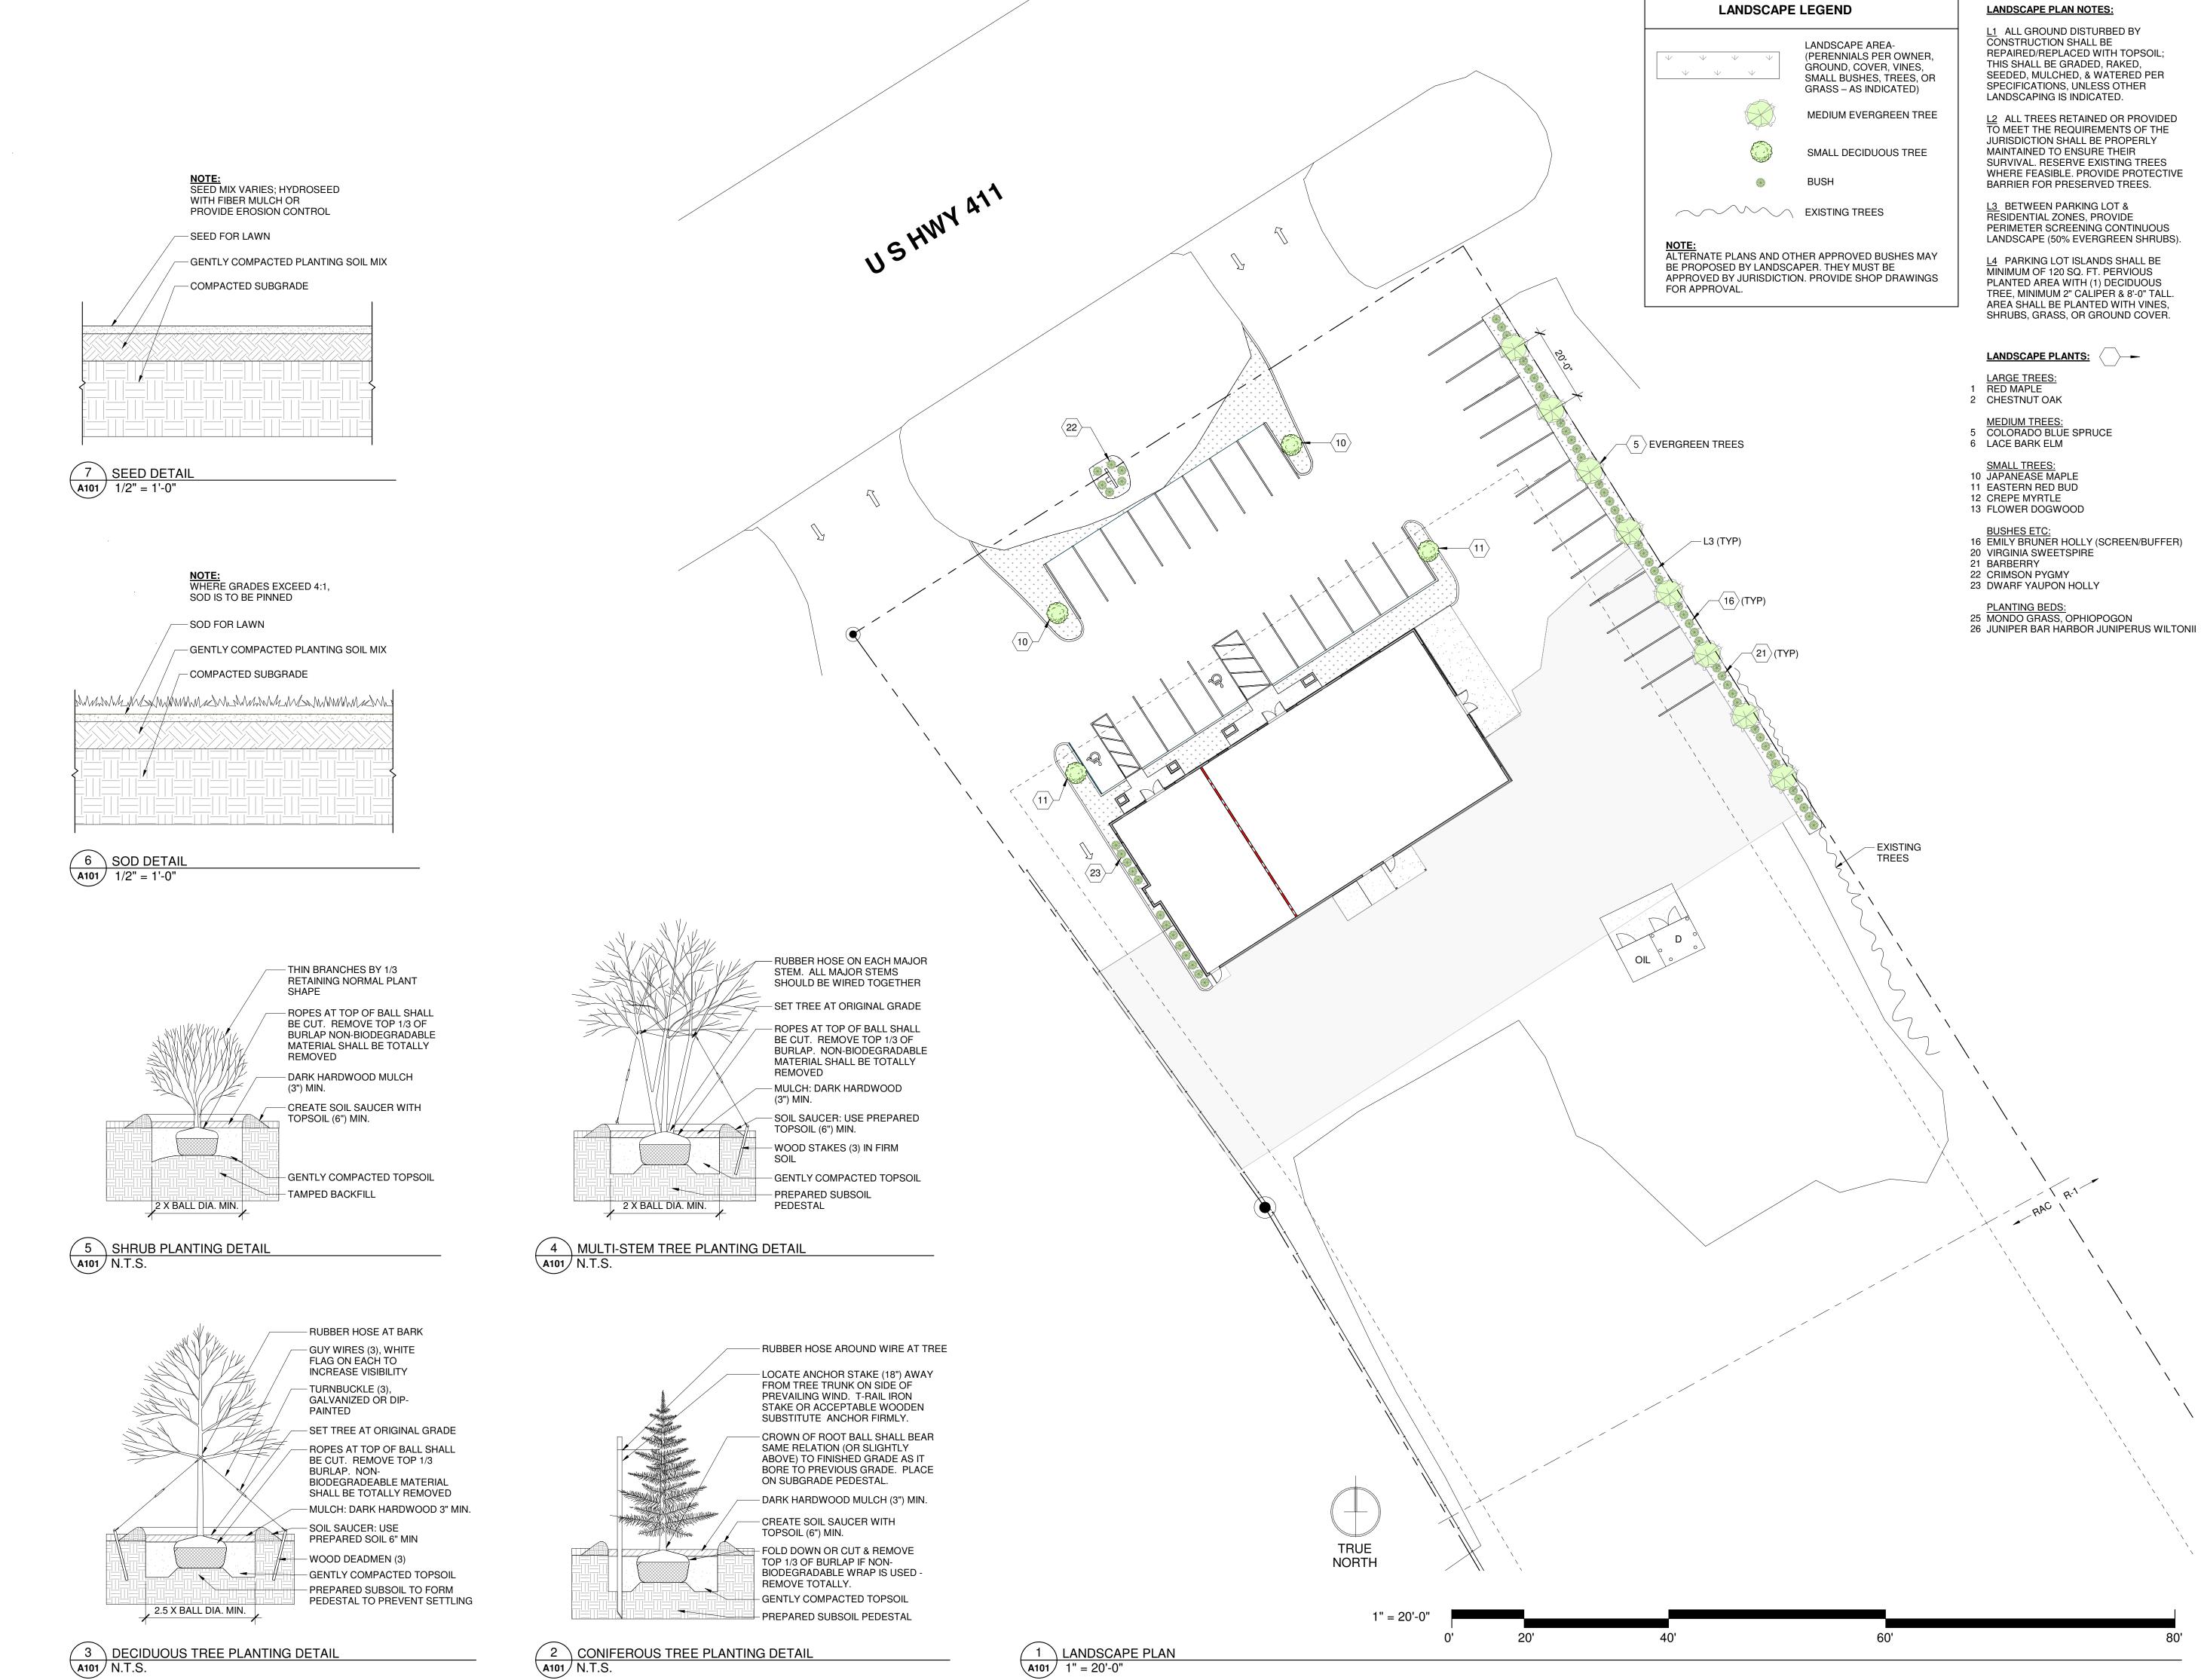

DEVELOAD.

PRELIMINARÝ FOR APPROVAL NOT FOR CONSTRUCTION /

Store

DRAWN BY: KG

LANDSCAPE PLAN

A101

PROJECT: 25091

Green Avenue, Suite 100 Knoxville, TN 37921 (865) 523-8200 office@oysk3architects.com

0.0

0.0

0.0

0.0

0

0

0.1

0

0

0.0

1"=1.6321' - Scale.

411 Restaurant & Tobacco Sto

Sam Patel

Design BY: HWH

E - 1

Photometrics


Sam Patel
5022 US HWY 411, Marwille, Tennessee.


37.801 37.801 37.801 37.801 1545 Wester 1589 1545 Wester 1589 153-85

PROJECT: 25091
© COPYRIGHT 2025


^ 	82 Watt Sec	7	Lithonia Lighting	TWR2 LED ALO-MED 40K UVOLT	1	12449	1	TWR2 LED, Medium Lumen Setting, 4000K Setting, 120-347V	82.1	Max: 5507cd
B	Can - 15W	5	Aculux	AX2 D G2 12LM 30K 80CRI 15D 2DPIN BD	1	1024	1	2" ROUND DOWNLIGHT ACULUX 15W LED, SPOT OPTIC	14.86	Max: 9929cd
^ _ C	Egre ss - 16 W	5	Lithonia Lighting	TWR1 LED ALO-LOW 50K UVOLT	1	2359	1	TWR1 LED, Low Lumen Setting, 5000K Setting, 120-347V	16	Max: 1138cd
☐ D	Floo d 39W	1	American Electric Lighting	75LED P10 XXXXX 55 4K FV	1	Absolute	1	75LED Floodlight P10 package 5x5 4000K CCT	39	Max: 4355cd
^ E	16W Sec	1	Lithonia Lighting	TWR1 LED ALO-LOW 50K UVOLT	1	2359	1	TWR1 LED, Low Lumen Setting, 5000K Setting, 120-347V	16	Max: 1138cd

- 1.Fixtures A and E are located 12 feet above grade level.
 2.Fixtures B and C are located 8 feet above grade level.
 3. Fixture D is located near ground level.
 4. This layout was produced using Visual Lighting 2020 Ver. (2.11.0094).

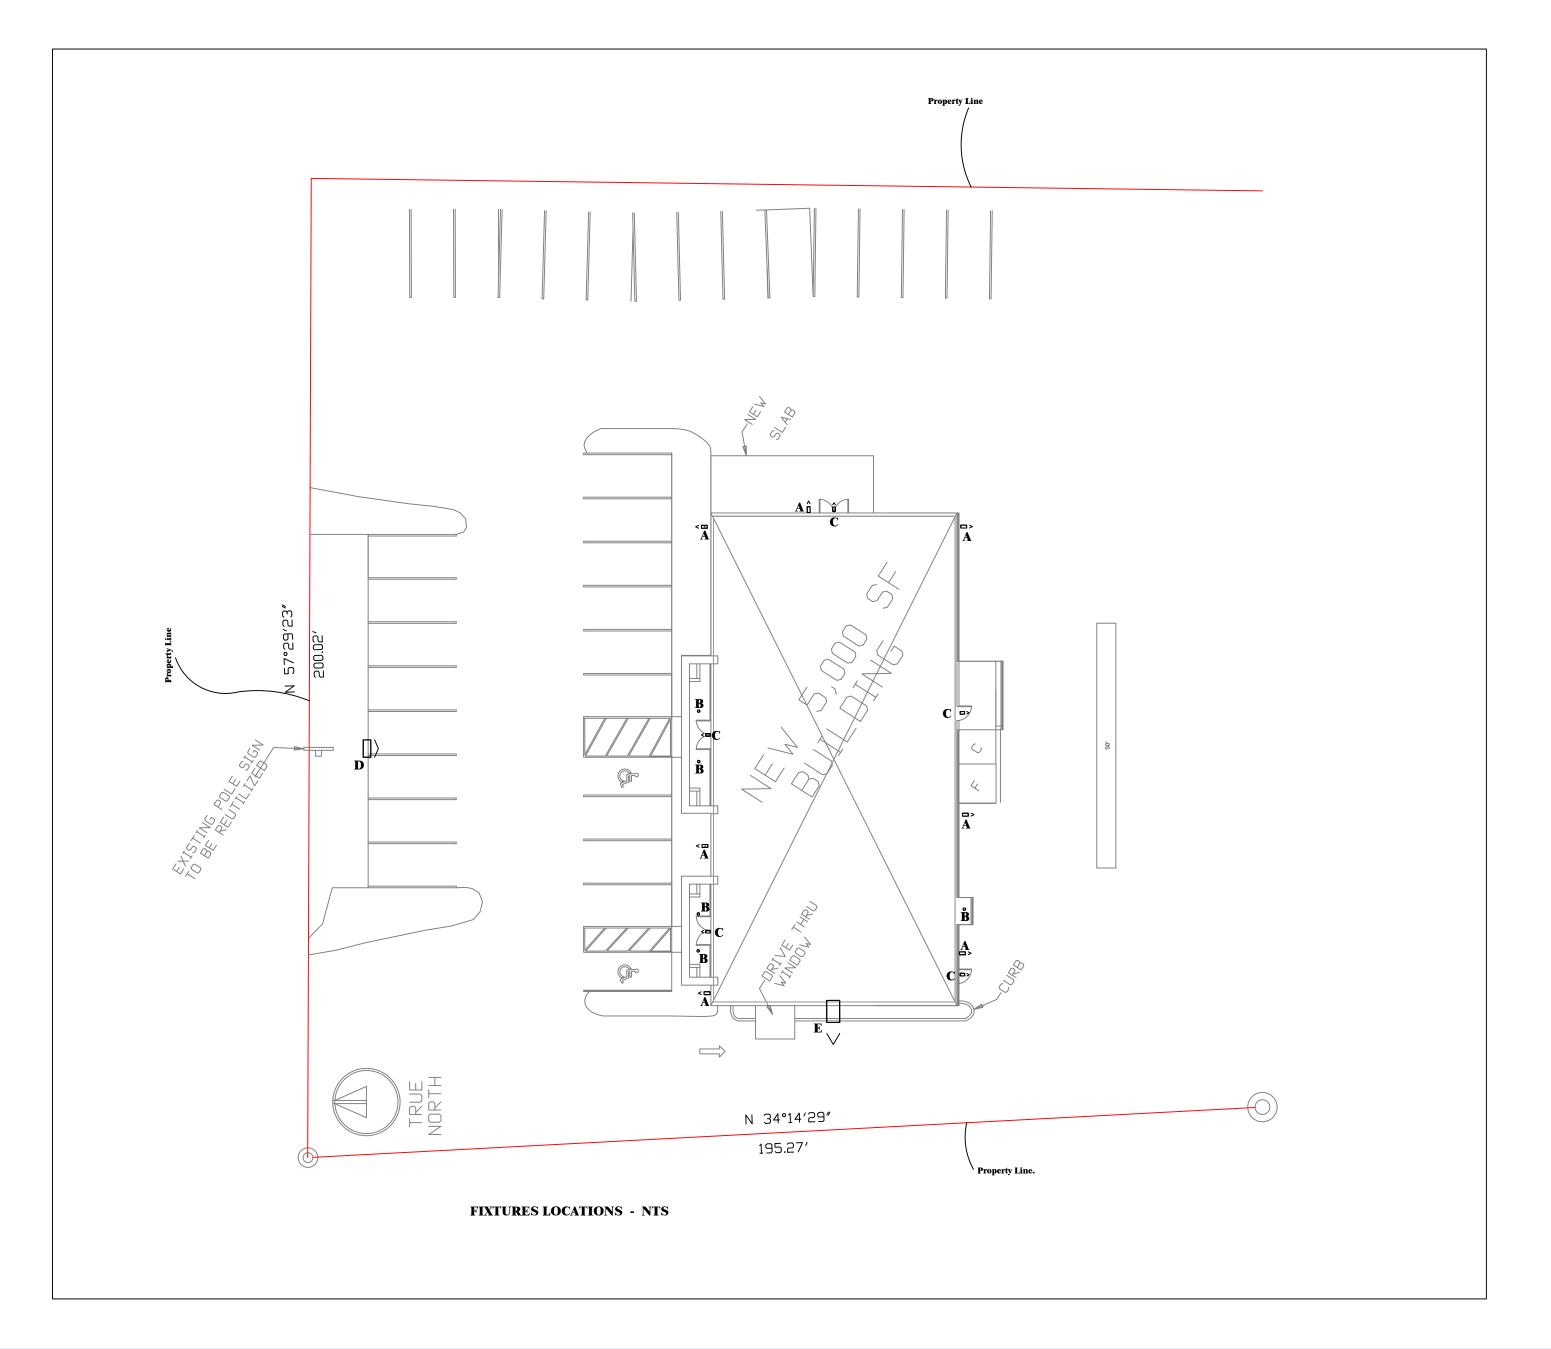

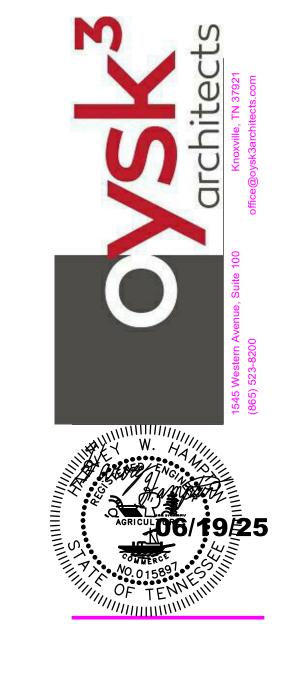



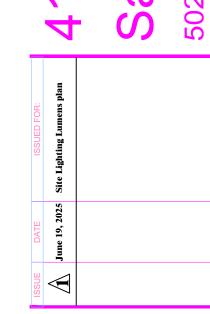

Design BY: HWH

E - 2 Photometrics

